


landscape detailed design

Autism Spectrum Australia Harrisons Lane

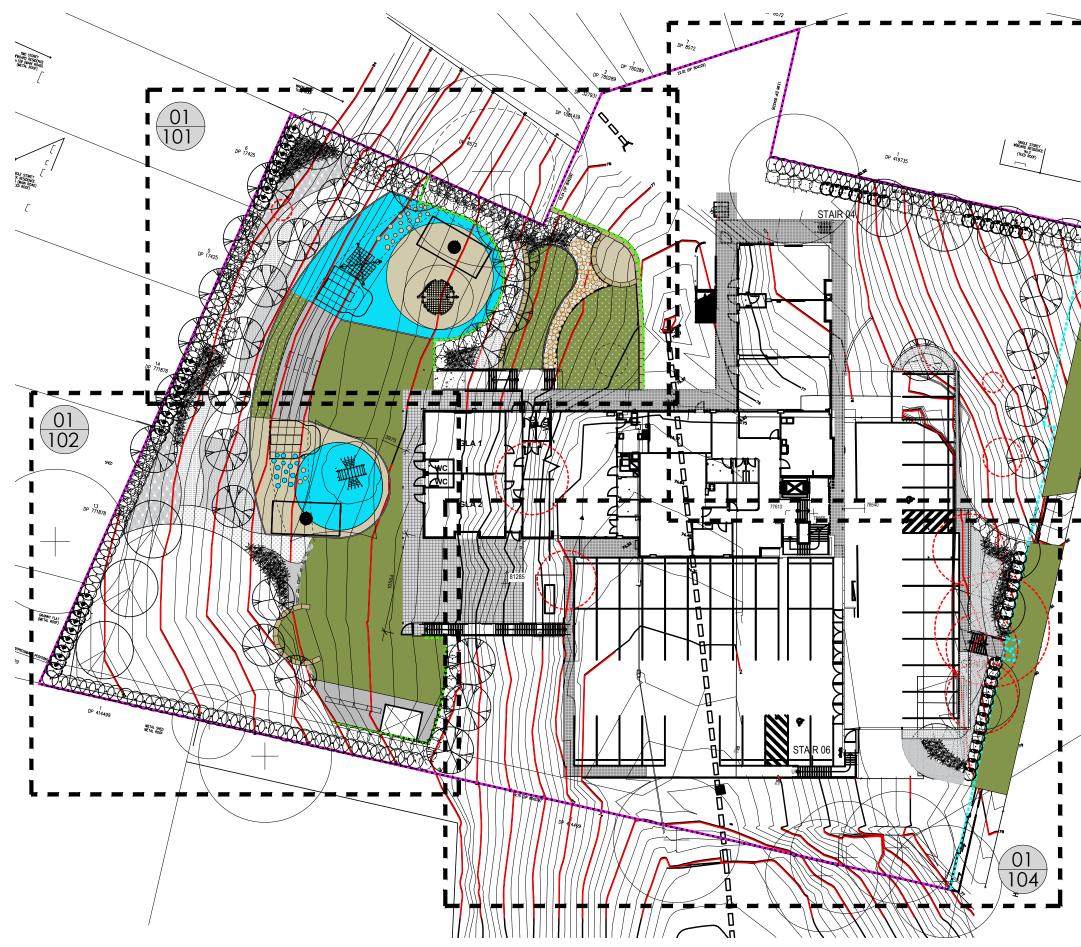



412 KING STREET NEWCASTLE NSW AUSTRALIA 2300 TERRAS.COM.AU PH: 49 294 926 FAX: 49 263 069



DRAWN: GF DATE: 22.09.23 SCALE: 1:400@A3 JOB NUMBER: PHASE: DWG No: REV: 13753.5 DD L002 M

Aspect Spectrum Australia

CLIENT:


Harrisons Lane Cardiff

SITE:

Aspect Autism School Site Plan

PROJECT:

М	22/09/23	TENDER
L	02/08/23	TENDER
К	25/07/23	TENDER
J	21/07/23	TENDER
1	03/05/23	TENDER
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REV	DATE	COMMENTS

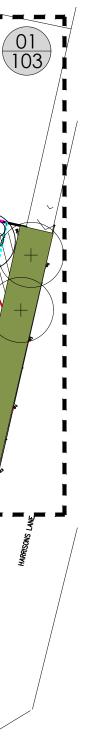



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ERRAS.COM.AU	PH: 49 2	94 926	5 FAX: 49 2	63 069



drawn: GF SCALE: 1:200@A3 DATE: 02.08.23 JOB NUMBER: PHASE: DWG NO: REV: 13753.5 DD L101 L

Aspect Spectrum Australia

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SITE:

Cardiff

CLIENT:

PROJECT:

08/02/23 DATE

Aspect Autism School

Landscape Plan 01

Harrisons Lane

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MASS PLANTING REFER TO PLANT SCHEDULE

SOFTFALL 1 REFER TO SPECIFICATIONS

SOFTFALL 2 REFER TO SPECIFICATIONS

PAVEMENT TYPE 1

PAVEMENT TYPE 2

PAVEMENT TYPE 3

TURF GRASS


SYNTHETIC TURF

SAND SOFTFALL

(+)	EXISTING TREES	
TAK	NEW TREES REFER TO PLANT SCHEDULE	SFI
	SHRUB / FEATURE PLANTING REFER TO PLANT SCHEDULE	SF2
PBI	RAISED PLANTERS / PRODUCTIVE GARDENS	Pl
SL1/SL2	SANDSTONE LOGS RETAINING / SEATS	P2
	CURVED TIMBER BENCHES	
C <u>P</u> L	TIMBER LOG STEPPERS	
	NATURAL ROCK	12
TE	TIMBER EDGE	S
	FENCE TYPE 1	
F2	FENCE TYPE 2	

LEGEND

FENCE TYPE 3

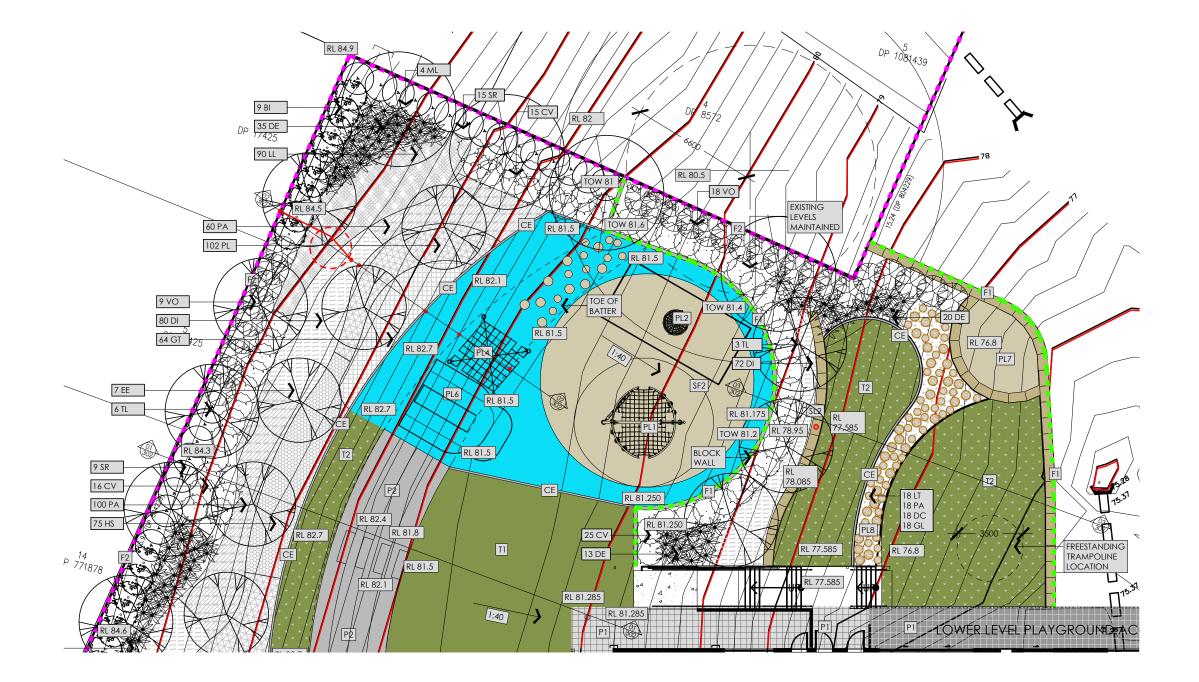

LEGEND

(+)	EXISTING TREES	
TAR	NEW TREES REFER TO PLANT SCHEDULE	
	SHRUB / FEATURE PLANTING REFER TO PLANT SCHEDULE	
	RAISED PLANTERS / PRODUCTIVE GARDENS	
SL1/SL2	SANDSTONE LOGS RETAINING / SEATS	
	CURVED TIMBER BENCHES	
O PU	TIMBER LOG STEPPERS	
	NATURAL ROCK	
TE	TIMBER EDGE	

FENCE TYPE 1

FENCE TYPE 3

FENCE TYPE 2

F2



MASS PLANTING REFER TO PLANT SCHEDULE

SOFTFALL 1 REFER TO SPECIFICATIONS

SOFTFALL 2 REFER TO SPECIFICATIONS

PAVEMENT TYPE 1

PAVEMENT TYPE 2

PAVEMENT TYPE 3

TURF GRASS

SYNTHETIC TURF



Ν	22/09/23	TENDER
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С	17/03/23	90% Detailed Design
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А	08/02/23	25% Detailed Design
REV	DATE	COMMENTS

PROJECT:

Aspect Autism School Landscape Plan 02

SITE:


Harrisons Lane Cardiff

CLIENT:

Aspect Spectrum Australia

DRAWN: DATE: SCALE: GF 22.09.23 1:250@A3 JOB NUMBER: PHASE: DWG NO: REV: **13753.5 DD L102 N**



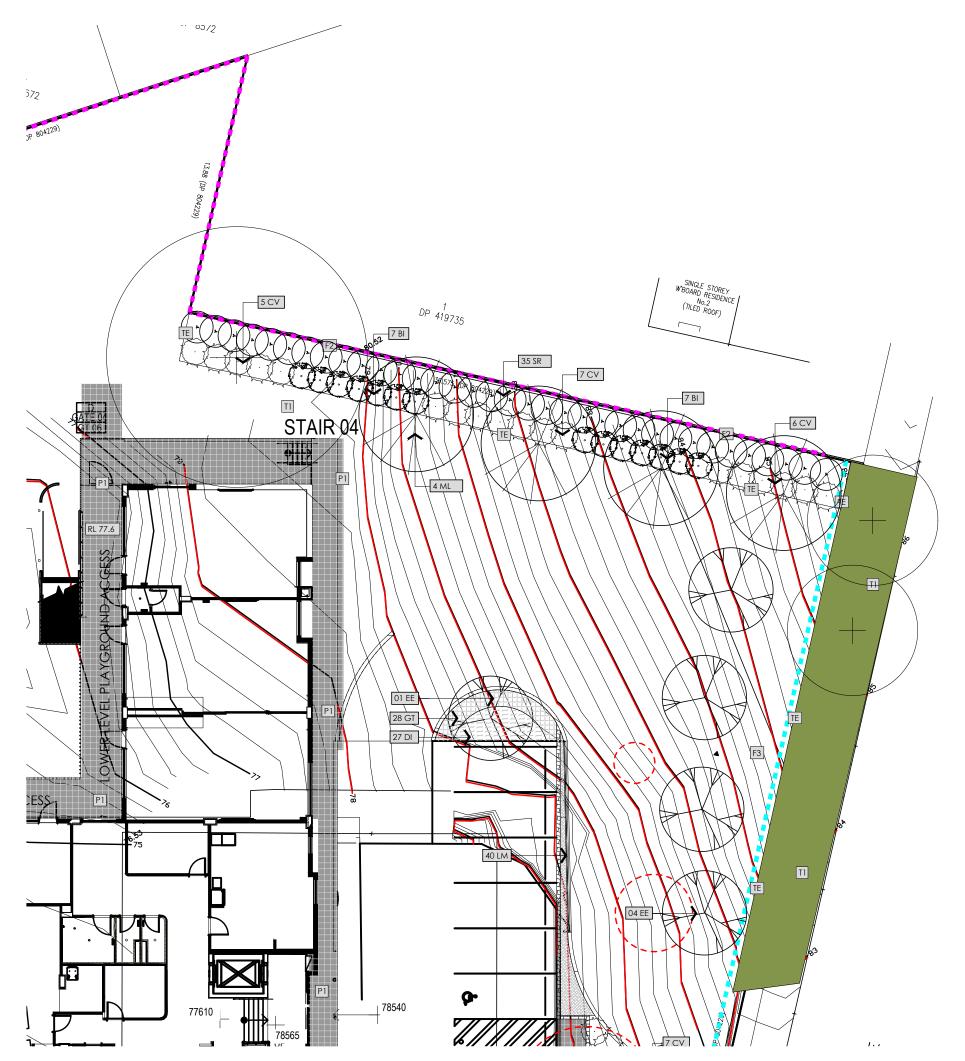

LEGEND

LEGEND		
(+)	EXISTING TREES	
TAR	NEW TREES REFER TO PLANT SCHEDULE	
	SHRUB / FEATURE PLANTING REFER TO PLANT SCHEDULE	
	RAISED PLANTERS / PRODUCTIVE GARDENS	
SL1/SL2	SANDSTONE LOGS RETAINING / SEATS	
	CURVED TIMBER BENCHES	
CP	TIMBER LOG STEPPERS	
CREDO	NATURAL ROCK	
TE	TIMBER EDGE	
	FENCE TYPE 1	
F2	FENCE TYPE 2	

FENCE TYPE 3



MASS PLANTING REFER TO PLANT SCHEDULE

SOFTFALL 1 REFER TO SPECIFICATIONS

SOFTFALL 2 REFER TO SPECIFICATIONS

PAVEMENT TYPE 1

PAVEMENT TYPE 2

PAVEMENT TYPE 3

TURF GRASS

SYNTHETIC TURF

SAND SOFTFALL

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RE\	V DATE	COMMENTS

PROJECT:

Aspect Autism School Landscape Plan 03

SITE:

Harrisons Lane Cardiff

Aspect Spectrum Australia

CLIENT:

DRAWN: GF DATE: 22.09.23 SCALE: 1:250@A3






LEGEND

(+)	EXISTING TREES
	NEW TREES REFER TO PLANT SCHEDULE
	SHRUB / FEATURE PLANTING REFER TO PLANT SCHEDULE
	RAISED PLANTERS / PRODUCTIVE GARDENS
SL1/SL2	SANDSTONE LOGS RETAINING / SEATS
	CURVED TIMBER BENCHES
C PI	TIMBER LOG STEPPERS
OF	NATURAL ROCK
TE	TIMBER EDGE
	FENCE TYPE 1

FENCE TYPE 2

FENCE TYPE 3

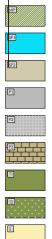

MASS PLANTING REFER TO PLANT SCHEDULE

SOFTFALL 1 REFER TO SPECIFICATIONS

SOFTFALL 2 REFER TO SPECIFICATIONS

PAVEMENT TYPE 1

PAVEMENT TYPE 2

PAVEMENT TYPE 3

TURF GRASS

SYNTHETIC TURF

SAND SOFTFALL

М	22/09/23	TENDER
L	02/08/23	TENDER
К	25/07/23	TENDER
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С	17/03/23	90% Detailed Design
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REV	DATE	COMMENTS

PROJECT:

Aspect Autism School

Landscape Plan 04


SITE: Harrisons Lane Cardiff

Aspect Spectrum Australia

CLIENT:






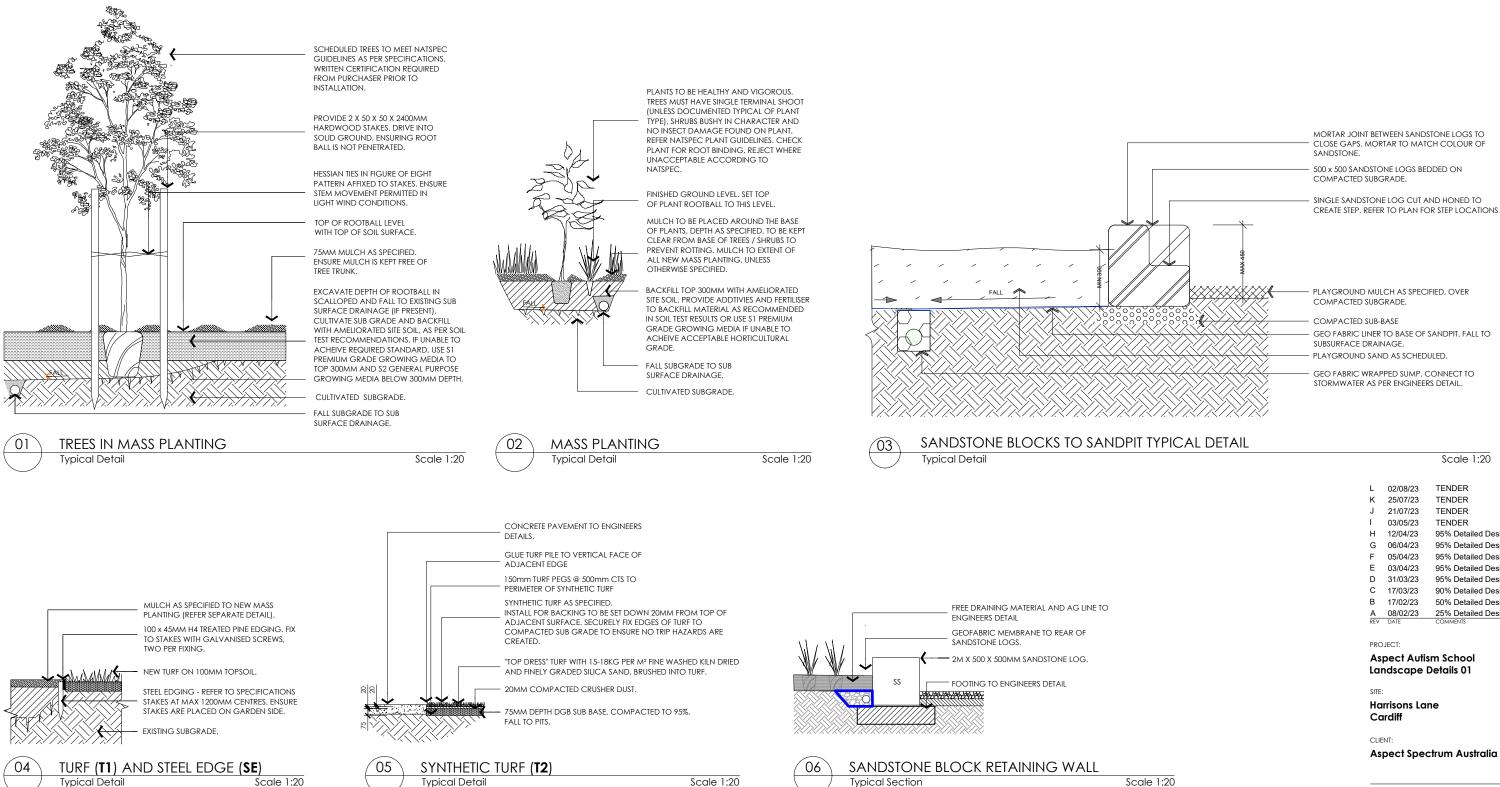

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REV	DATE	COMMENTS





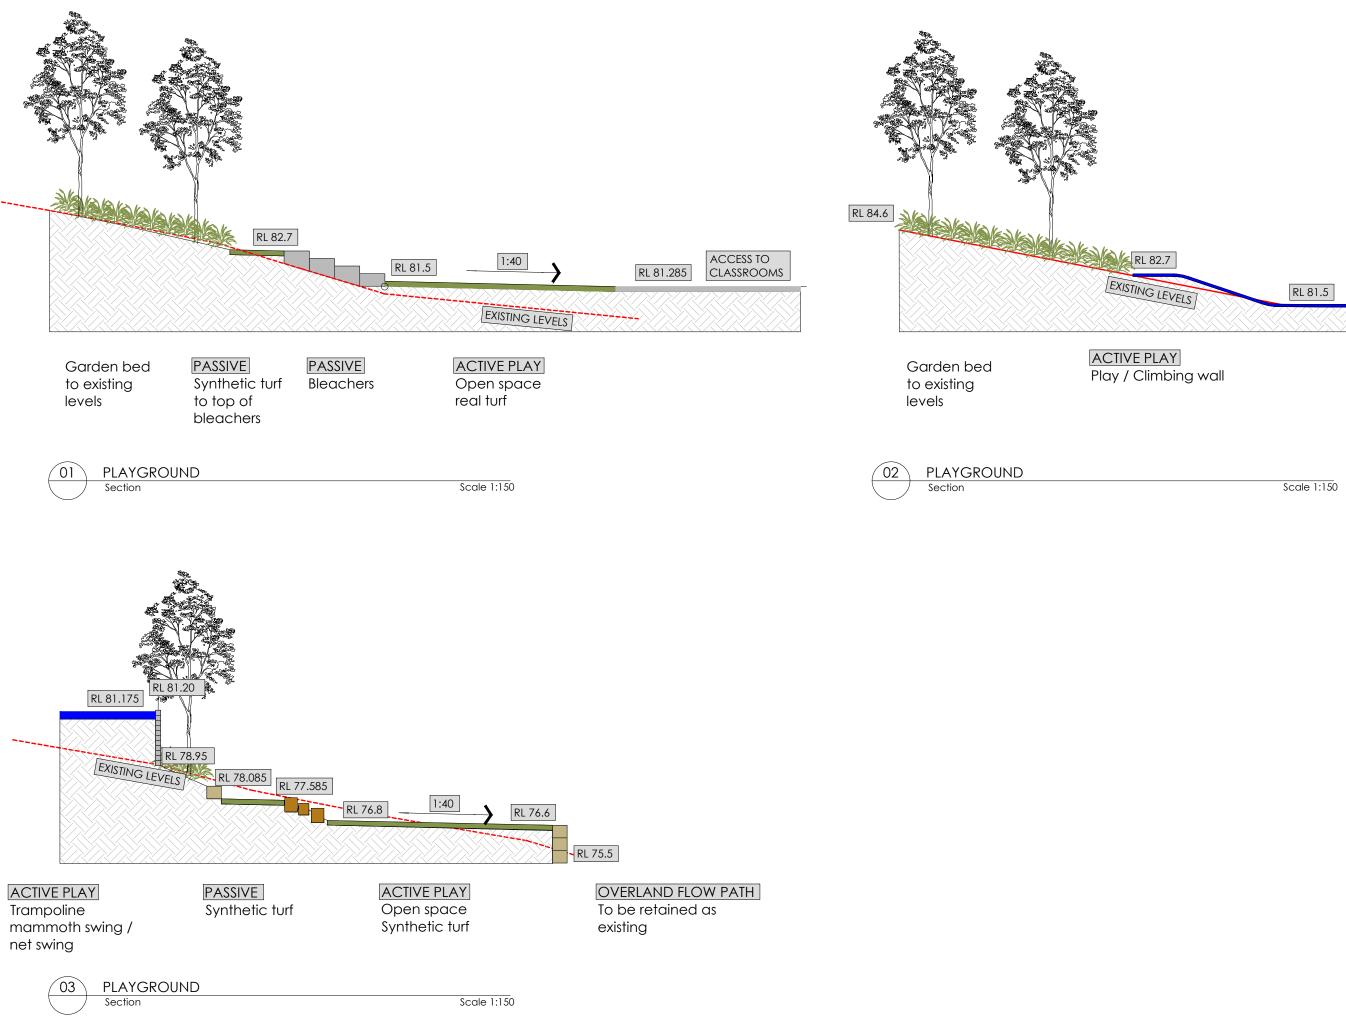





JOB NUMBER: PHASE: DWG NO: REV: 13753.5 T L302 N

drawn: GF

DATE: SCALE: 22.09.23 AS SHOWN@A3

CLIENT: Aspect Spectrum Australia

Cardiff

SITE: Harrisons Lane

Aspect Autism School Landscape Details 02

PROJECT:

Ν	22/09/23	TENDER
М	07/09/23	TENDER
L	02/08/23	TENDER
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н	12/04/23	95% Detailed Design
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С	17/03/23	90% Detailed Design
в	17/02/23	50% Detailed Design
Α	08/02/23	25% Detailed Design
REV	DATE	COMMENTS

GENERALLY

All landscape works shall be carried out by members of the landscape contractors' association of NSW & ACT or who are eliaible to successfully obtain membership. The Contractor shall allow for all restriction to his operations caused as a result of other contractors, likely damage to existing structures, fences, retaining walls, pavements, services or other improvements either within or outside the site. The Contractor shall be responsible for ensuring that full and adequate protection from damage shall be provided to all finished surfaces and material subject to staining or other disfigurement, and shall be responsible for making good all damages and disfigurement. It is the responsibility of the contractor to supply a dilapidation report to the Superintendent documenting any prior damage before commencing work on site.

Check with engineer's drawings to see extent of earthwork, drainage, changes in and location of services, coordinated works as required.

Making good shall apply to any area affected by the contractor that does not form part of the trial works and shall include but not be limited to the contractor's compound, stockpile areas, sedimentation and erosion control measures, etc. Making good shall require the contractor to repair any damage and/or return disturbed areas to a pre-construction state and may involve some or all of the followina:-

-Removing all contractor's structures (eg. site sheds), fences, barriers, unused or unwanted materials:

-Removing contaminants and affected ground; -Returning levels to existing; -Decompaction: -Ripping; -Spreading topsoil -Resurfacing (including turfing and revegetation).

STANDARDS

REFERENCED DOCUMENTS:

- AS 2303 Tree Stock for Landscape Use 2015
- AS 4454 Composts, Soil Conditioners and Mulches 2003

AS 4373 Pruning of Amenity Trees - 2007

AS 4970 Protection of Trees on Development Sites - 2009

Soils for Landscape Development, Selection, Specification & Validation (Leake & Haege) - 2014

ORDERING

REQUIREMENT: Within 14 days of the date of acceptance of tender, furnish proof of ordering the required materials, and advise immediately if any supply difficulties are encountered. Substitutions shall not be approved unless accepted in writing by the supervisor. The plant schedule shall be the accepted document for plant quantities and sizes to be used for the project. Where discrepancies arise between the drawings and the plant schedule seek clarification from the supervisor as soon as practicable

INSPECTION - HOLD / WITNESS POINTS

It is the responsibility of the contractor to contact and co-ordinate with the Superintendent during the construction period for hold points / witness points.

NOTE:

Hold points (HP) require inspection by Terras Landscape Architects in order to complete final signoff. Written approval is required to proceed.

Witness Points (WP) require verbal approval to proceed and approvals dates and contacts shall be diarised as evidence of approval.

Give minimum two (2) days notice (unless otherwise indicated) to the Principals authorised person for inspections to be made at the following stages, as applicable. Do not proceed with further works until formal approval is provided from the authorised person for each of the hold points. Contractor shall be required to amend / alter any works completed without hold points reviewed

Extent, excavation and setout of proposed hardworks (HP).

Clarification on site of set-out points for any trenching or utility realignment (HP).

Form work and reinforcing (HP).

- Pre-pour inspections for pavement and pathways (HP).
- Conduits setout (WP).

Set out and inspection of permeable pavement (HP).

Trial oxide coloured payements samples (HP)

Plants available on site or local nursery prior to planting (HP).

Subgrades cultivated and/or prepared prior to placing topsoil (HP).

Plant material set out before planting (WP)

Planting, staking and tying completed (WP).

Review of works as executed with nominated Terras Landscape Architects and Council's Project Officer prior to completion report sign off (HP).

Practical completion: Completion of all landscape works as documented on the drawings (HP). Completion of planting establishment work / defects periods (HP).

TREES

TREES SHALL COMPLY WITH AS 2303 TREE STOCK FOR LANDSCAPE USE 2015.

Written evidence of compliance to be submitted prior to delivery on site. This is to be in the form of a written report and / or checklist and include photos.

INSPECTION OF TREES

The following is a summary of the Natspec 2 guide and does not replace the full requirements contained therein.

TIMING: Trees may be inspected before shipment.

PARTIAL SAMPLING: Expose a small section of the rootball, by washing, sufficient to permit inspection of root development from the stem to the outer extremity. After inspection, carefully replace soil.

Root systems: Root systems may be inspected using partial sampling at the rates nominated in AS 2303

FORWARD ORDER CONTRACTS: Submit regular reports in writing to the contract administrator. Include checks against specification requirements, and current photographs.

Inspection frequency: 3 months Report frequency: 3 months.

<u>COMPLIANCE</u>: Non-compliance may lead to rejection of the entire batch.

Substitution: If non-complying trees are proposed, submit proposal in writing to the contract administrator. Only written approvals of substitution are recognised. Submit a copy of the written

approval of substitution with the non-complying trees. HOLDING PROPOSALS: Submit proposals in writing to the contract administrator for proposed

methods for holding trees beyond specified dates so that trees will continue to comply SHIPMENT: Responsibility of Landscape Contractor.

BULK MATERIALS: 2 kg sample of each type specified. Submit bulk material samples, not less than 2 working days before bulk deliveries.

EXISTING SERVICES

Existing services on site may include but not limited to storm water drainage, water, and associated power service conduits. Locations of all services should be established prior to excavation and cultivation of planting beds and installation of trees etc. Do not excavate by machine within 1m of existing underground services without prior approval or identification of service locations. Services locations where shown are approximate only, the true location of actual in ground services must be determined by the contractor on site.

WORK NEAR TREES

PROTECTION: Protect trees to be retained from damage. Take necessary precautions. Do not store or otherwise place bulk materials and harmful materials under or near trees. Do not place spoil from excavations against tree trunks, even for short periods. Prevent damage to tree bark. Do not attach stays, guys and the like to trees. Avoid compaction of the ground under trees. WORK UNDER TREES: Do not add or remove topsoil within the Tree Protection Zone (TPZ) or drip

line (whichever is the greater. Use hand methods such that root systems are preserved intact and undamaged. Open up excavations under tree canopies for as short a period as possible. Ensure all cuts are clean using sharp and uncontaminated tools.

ROOTS: Where it is necessary to cut tree roots, use means such that the cutting does not unduly disturb the remaining root system.

DAMAGES: Any damage to trees to be retained will be attended to by a qualified arborist who will prepare a report covering rectification works. Submit report to supervisor for approval. Conduct remedial works as required including removal and replacement if so recommended. All costs to be borne by the contractor.

WEEDS

Eradicate weeds by environmentally acceptable methods using a non-residual Glyphosate herbicide at the manufacturer's recommended rates. Regularly remove, by hand, rubbish and weed growth that may occur or recur throughout grassed, planted and mulched greas. Continue eradication throughout the course of the works and during the Planting Establishment Period so that a weed free area is established at completion of the establishment period.

SETOUT AND DIMENSIONS

Critical design dimensions shall be obtained by the landscape contractor by survey before commencing work. Check engineers drawings to determine extent of earthworks, structures.

SUBSOIL DRAINAGE

SCOPE: Provide sub soil drains to all mass planting beds and as indicated and where necessary to intercept groundwater seepage and prevent water build up behind retaining walls and under pavement. Connect subsoil drains to the stormwater drainage system. Refer to plans and details

Ensure that under concrete conduits are installed for irrigation pipes (where applicable). STANDARD: To AS 3500.

INSPECTION: Give sufficient notice so that inspection may be made at the following stages: - Sub-soil drainage laid in position prior to covering.

CONNECTION: If connection into an existing drain is required, carry out the excavation necessary to locate and expose the connection point. On completion, reinstate the surfaces and elements which have been disturbed such as roads, pavements, kerbs, footpaths and nature strips

PIPE DEPTH: Comply with the following minimum depths, measured to the crown of the pipe:

- 100mm below formation level of the pavement, kerb or channel.

- 100mm below the average gradient of the bottoms of footings.

- 450mm below the finished surface of unpaved ground.

SUBSOIL DRAINS:

PERFORATED PLASTIC PIPE: To AS 2439.1 DIAMETER: 90mm JUNCTIONS: Use purpose made fittings BACKEILLING: Backfill with 20mm nominal size washed screenings, to the following depths: To the underside of the bases of overlying structures such as pavements, slabs and channels. - To within 75mm of the finished surface of unpaved or unhandicapped areas. FILTER FABRIC: Use polymeric fabric formed from a plastic yarn containing stabilizers or inhibitors to make the filaments resistant to deterioration due to UV light. IDENTIFICATION AND MARKING: TO AS 3705 PROTECTION: Protect the fabric from prolonged exposure to sunlight. Filter sock: Use an approved permeable polyester sock capable of retaining particles of 0.25mm size. Securely fit or join the sock at each joint by tape or other approved means.

MULCH

GENERALLY: Use mulch as scheduled which is free of deleterious and extraneous matter such as soil, weeds and sticks. Use organic mulches which are free of stones and comply with Australian Standards specifying less than 5% fines. Use first well rotted mulch chipped on site, chip to match ANL 'Forest Blend' 20-40mm mulch. Additional mulch to be made from 100% recycled Grade A green waste and waste wood equal to Australian Native Landscape's Forest Blend® (20-40 mm)

APPLICATION: Place mulch to the required depth, clear of plant stems, and rake to an even surface flush with the surrounding finished levels.

SOILS

TESTING

Undertake soil tests on stockpiled soil designated for re-use, or imported organic soil, if requested and provide copies of test results to the Superintendent. Ameliorate as recommended in soil tests to bring soil up to the standards for horticultural grade organic soil to Australian Standards. GENERAL: To Soils for Landscape Development, Selection, Specification and Validation, by Simone Leake and Elke Haege (2014).

SUBSOIL PREPARATION

CULTIVATION: Cultivate bases of planting holes and beds 150mm, do not use augers unless followed with cultivation of sides and base. Do not disturb services or tree roots; if necessary cultivate these areas by hand. Cultivate manually within 300 mm of paths or structures. Remove stones exceeding 25 mm, clods of earth exceeding 50 mm, and any weeds, rubbish or other deleterious material brought to the surface during cultivation. Trim the surface to the required design levels after cultivation.

SUBSOIL ADDITIVES

ADDITIVES: Apply required additives to stockpiled site topsoil as required by soil tests if scheduled in this specification

GYPSUM: Provide 150g/m.sq gypsum to base of all tree planting locations unless otherwise approved

SOIL LEVELS

Finished soil levels shall allow turf or mulch to be finished level to the top of timber edging, payement or as otherwise shown on drawings.

DRAINAGE: The contractor shall incorporate drainage to the bottom of the area of soil as indicated in the working drawing, which connects to the stormwater system. Provide free drainage aggregate above drainage lines to the top of new soil levels to ensure vertical drainage from surface.

PLACING SOIL: Place the approved soil on the prepared subsoil. Spread and grade evenly, making the necessary allowances so that the required finished levels and contours may be achieved after light compaction. Prevent areas of excess compaction being caused by constructional plant. Avoid differential subsidence and produce a finished soil surface which is:

- at desian levels smooth and free from stones or lumps of soil;
- graded to drain freely, without ponding, to catchment points; graded evenly into adjoining ground surfaces; and
- ready for planting.

COMPOST

DESCRIPTION: Well rotted vegetative material or animal manure, or other approved material, free from harmful chemicals, grass and weed growth, and with a neutral Ph value.

SOIL ADDITIVES

Provide proprietary soil additives, delivered to the site in sealed packaging marked to show manufacturer's or vendor's, name, weight, type (including analysis), recommended uses and application rates. Use in accordance with the manufacturer's recommendations. Apply to each plant/planting hole as applicable. (Note: turf to be broadscale)

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С	17/03/23	90% Detailed Design
В	17/02/23	50% Detailed Design
Α	08/02/23	25% Detailed Design
REV	DATE	COMMENTS

PROJECT:

Aspect Autism School **Specifications 01**

SITE:

Harrisons Lane Cardiff

CLIENT:

Aspect Spectrum Australia



LANDSCAPE HARDWORKS

CONCRETE

GENERAL: The Contractor shall ensure that any concrete footways designated for retention are protected during the works, by the placement of signs, lights and barricades around the area as directed by the Superintendent.

The Contractor shall ensure that a smooth transition occurs with all adjoining surfaces. STANDARDS:

Specification and supply: To A\$1379.

Materials and construction: To AS3600.

Guide to residential pavements: To AS 3727.

The requirements for in situ concrete may be varied if it is reinforced. A\$3727 can then be used for design purposes.

JOINTS:

Control Joints: Refer civil engineers documentation.

Expansion Joints: Refer civil engineers documentation.

Abutment with building: Where concrete paving more than 1500mm wide abuts the wall of a building, cast-in 10mm thick bitumen impregnated fibreboard between the paving and the wall. Otherwise, turn up the vapour barrier.

FINISHING METHODS:

Broom finishing: Wood float and broom to an even textured transverse scored surface with steel tooled margins. On gradients steeper than 10%, roughen the surface by scoring using a stiff brush or rake.

The texture or scoring is required to achieve a slip resistant surface.

Exposed aggregate finish: Steel trowel to a smooth surface. After final set use clean water and brushes to remove the surface film of mortar until the aggregate is uniformly exposed without under cutting of the matrix.

MATERIALS AND WORKMANSHIP

SCOPE: Concrete base slab to paved areas, exposed aggregate, steps and footings to walls and retaining walls, where appropriate as shown on plan.

FINISHES: The surface of the footpaths indicated as concrete finish shall be finished true and uniform and free from any glazed or trowelled finish and shall be finally dressed with a wooden float followed by a light brooming to give a uniform non-slip surface and shall be of coloured / uncoloured concrete as noted on landscape plans. Edges and tooled joints shall be smooth trowelled finish.

SUB-GRADE/SUB-BASE: All concrete shall be cast on an approved compacted sub-grade or sub-base which shall be dampened immediately prior to placing concrete. Sub-base concrete to have falls as shown on the drawings.

PUBLIC UTILITIES ETC: Location of public utilities shall be the Contractor's responsibility. Any adjustment or repair of damage to any public utility shall be the Contractor's responsibility and shall be carried out at no cost to the Principal.

Any alteration to Council drainage facilities, road pavement, etc., necessary for undertaking of works will be at the Contractor's full cost.

SURVEY MARKS: Survey marks may be found on the adjoining site as part of the field work for the survey provided, however it shall be the contractors responsibility to accurately determine the extent of work as shown, the site boundaries, setout and levels.

Note: The Surveyors' Act, the Survey Co-ordination Act and Ordinance 30 all prohibit the unlawful destruction of survey marks and anyone who so destroys a survey mark is liable to a fine plus re-establishment costs.

AD.JACENT FOOTWAY: Any damage to footway paying surfaces shall be repaired by and at cost to the contractor. Where removal of existing concrete or asphalt is necessary, edges to be saw cut to the satisfaction of the Superintendent

DEFECTIVE WORK: Any defects in the works caused by faulty materials, poor workmanship or other damage, shall be rectified or replaced by the Contractor at no cost to the Principal, to the requirements of the Superintendent.

PEDESTRIAN SURFACES

All surfaces subject to pedestrian traffic shall meet the minimum pendulum or ramp recommendations contained in Table 3 of Australian Standard Handbook HB 197:1999 An Introductory Guide to the Slip Resistance of Pedestrian Surface Materials.

Compliance with the recommendations shall be verified by testing to either: AS/NZS 4586:1999 Slip Resistance Classification of New Pedestrian Surface Materials or, AS/NZS 4663:2002 Slip Resistance Measurement of Existing Pedestrian Surfaces as appropriate.

In both instances compliance shall be demonstrated by applying Clause 5.3 Means of Demonstrating Compliance of AS/NZS 5486:1999 Slip Resistance Classification of New Pedestrian Surface Materials.

EDGING

TIMBER EDGING (TE): Shall be assumed to be laid to the edges of all mass planting beds that aravel or mulched areas. Timber edaina shall be fixed so that it does not interface with turf lift, twist or create a trip hazard and finish flush with adjoining surfaces.

GALV STEEL (SE): 150 x 1.6mm hot dipped galvanised steel edging equal to' Form Boss', fixed with 400 x 2.5mm galvanised steel tapered stakes and galvanised self tapping screws.

Installation: As per manufacturers specifications.

CONCRETE (CE): Machine extruded concrete mix to size and profile noted in schedule.

Installation: Preparation and installation as per manufacturers specifications.

MATERIAL: Refer to Schedule of Materials and Finishes.

LANDSCAPE SOFTWORKS

PLANTS

Supply plants to the following quality:

-are vigorous, well established, free from disease and pests, of good foliage, have large healthy root systems, with no evidence of root curl, restriction or damage

-are hardened off, not soft or forced, and suitable for planting in the natural climatic conditions prevailing at the site.

-do not require staking to stand upright other than staking to control damage from strong winds or local conditions.

Staking should then be as detailed on the drawings and provide free movement with support only to protect from excessive movement.

SAMPLES: All plants shall be made available for inspection on site or at local nursery. The entire material represented may be rejected, except for plants with a correctable defect subject to satisfactory treatment

SUBSTITUTIONS: Make no substitutions, unless approved by Superintendent.

CERTIFICATES: Refer Contractor's Submissions section for required certificates.

LABELLING: Label at least one plant in every 50 of each species or variety in each batch of plants delivered to the site, with a durable, readable taa.

REPLACEMENTS: Using plants of the same type, quality and size, replace any plants which are damaged whilst being transported to the site or during the work under the Contract, or which fail or are rejected.

STORAGE: Deliver plant material to the site on a day to day basis, and plant immediately after delivery. If this is not possible, keep the plants in good condition on the site, adequately protected from frost, wind, sun and vermin by appropriate storage methods, including an on-site nurserv of sufficient size, with provision for watering the stock.

PLANT CONTAINERS: Supply plants in weed-free containers of the scheduled size.

POTTING-ON: Do not carry out potting-on unless authorised.

PLANT SCHEDULE: Plant quantities species, planting rates and source shall be as noted on landscape drawings allowing for extra replacements.

LOCATIONS: If it appears necessary to vary plant locations and spacings to avoid service lines, or to cover the area uniformly, or for other reasons, contact the Landscape Architect for approval. No changes are to be made without prior approval.

PLANTING CONDITIONS: Do not plant in unsuitable weather conditions such as extreme heat, cold, wind or rain. In other than sandy soils, suspend excavation when the soil is wet, or during frost periods

WATERING: Thoroughly water the plants before planting, immediately after planting, and as required to maintain growth rates free of stress. Once established, progressively reduce watering over a 4 week period, hardening off to the natural climatic conditions.

WETTING AGENT: Undertake a single application of wetting agent to advanced trees after planting.

TURFING

TURF: Obtain turf from a specialist grower of cultivated turf. Use turf of even thickness, free from weeds and other foreian matter.

SUPPLY: Deliver the turf within 24 hours of cutting, and lay it within 36 hours of cutting. Prevent it from drying out between cutting and laying.

FERTILISING: Mix the fertiliser thoroughly into the topsoil before placing the turf. Apply lawn fertiliser at the completion of the first and last mowings, and at other times as required to maintain healthy grass cover.

LAYING: Lay the turf in the following manner:

In stretcher pattern with the joints staggered and close butted.

Parallel with the long sides of level areas, and with contours on slopes.

To finish flush, after tamping, with adjacent finished surfaces of ground, paving edging, or grass seeded areas

TAMPING: Lightly tamp to an even surface immediately after laying. Do not use a roller.

WATERING: Water immediately after laying until the topsoil is moistened to its full depth. Continue watering to maintain moisture to this depth. Keep the grass in a healthy condition.

MOWING: Mow to maintain the grass height within the required range. Carry out the last mowing not more than seven days before the end of the planting establishment period. Remove grass clippings from the site after each mowing.

MAINTENANCE: Maintain the turfed areas until the attainment of a dense continuous sward of healthy and evenly green grass over the whole area. Lift failed turf and relay with new turf.

TOP DRESSING: When the turf is established mow, remove cuttings and lightly top dress entire turf area to a depth of 10 mm. Rub the dressing well into the joints and correct any unevenness in the turf surface.

PLANT ESTABLISHMENT

PERIOD: The Planting Establishment Period commences at the date of issue of a written certificate of Practical Completion from the Superintendent PROGRAM: Furnish a proposed planting maintenance program with the tender

LOG BOOK: Keep a log book recording when and what maintenance work has been done and what materials, including toxic materials, have been used. The logbook is to be progressively updated at the completion of each day's work. Make the log book available for inspection on request.

RECURRENT WORKS: Throughout the Planting Establishment Period, continue to carry out recurrent works of a maintenance nature including, but not limited to, watering, mowing, weeding, rubbish removal, fertilising, pest and disease control, staking and tying, replanting, cultivating, pruning and keeping the site neat and tidy.

REPLACEMENTS: Continue to replace failed, damaged or stolen plants for the extent of the Planting Establishment Period.

MULCHED SURFACES: Maintain the surface in a clean and tidy condition and reinstate the mulch as necessary

STAKES AND TIES: Adjust or replace as required. Remove those not required at the end of the Planting Establishment Period. Prune trees as directed by the landscape architect

WATER: The contractor shall be responsible for sourcing, checking availability and if required importing water to maintain the plants during the plant establishment period as required under this specification.

NOTES:

CHECK WITH ENGINEERS DRAWINGS WHEN AVAILABLE TO SEE EXTENT OF EARTHWORK, DRAINAGE, CHANGES IN AND LOCATION OF SERVICES, CO-ORDINATE WORKS AS REQUIRED.

PLANT NUMBERS ON LANDSCAPE PLAN TAKE PRECEDENCE OVER NUMBERS ON PLANT SCHEDULE

TREES MUST BE CERTIFIED TO AUSTRALIAN STANDARDS AND A WRITTEN INSPECTION REPORT WITH PHOTOGRAPHS OF ROOTS FOR CERTIFICATION FROM THE NURSERY PRIOR TO DELIVERY TO SITE

NOTIFY SITE SUPERINTENDENT WHEN TREES ARE AVAILABLE ON SITE FOR INSPECTION TO ENSURE AUSTRALIAN STANDARD COMPLIANCE PRIOR TO PLANTING.

TREES THAT DO NOT COMPLY SHALL BE REJECTED AND THE CONTRACTOR REQUESTED TO SUPPLY COMPLYING PLANTS.

L	02/08/23	TENDER
к	25/07/23	TENDER
J	21/07/23	TENDER
1	03/05/23	TENDER
н	12/04/23	95% Detailed Design
G	06/04/23	95% Detailed Design
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С	17/03/23	90% Detailed Design
В	17/02/23	50% Detailed Design
А	08/02/23	25% Detailed Design
REV	DATE	COMMENTS

PROJECT:

Aspect Autism School Specifications 02

SITE

Harrisons Lane Cardiff

CLIENT:

Aspect Spectrum Australia



SCHEDULES - GENERAL

CULTIVATION SCHED	ULE	
LOCATION	DEPTH (MM)	NOTES
Subgrade	100	

DEFECTS SCHEDULE						
TYPE PERIOD		NOTES				
Plant Establishment Period (Softworks). All new plantings & turf areas	52 Weeks	From date of written acceptance of Practical Completion for landscape works.				
Defects Period (Hardworks).	52 Weeks	From date of written acceptance of Practical Completion for landscape works.				

EXCAVATION SCHEDULE

LOCATION	DEPTH (MM)	NOTES			
Mass Planting	400	To allow for 300mm topsoil, 75mm mulch + 25mm setdown from edge.Cultivate base and sides, fall base to drainage.			
Turf	200	Ensure no ponding.			
Trees	Refer detail	Refer detail.			

FERTILISER / ADDITIVES SCHEDULE

LOCATION	ТҮРЕ	N:P:K RATIO			
Mass Planting	An ongoing fertiliser	regime as per soil test results.			
Mass Planting (Pre-Planting)	A mix of water crystals, wetting agent, inert carrier and fertilisers.	Equal to Terracottem or Terraform.			
Mass Planting (Post-Planting)	Seaweed based soil conditioner with plant growth regulators.	Seasol			
Mass Planting (Maintenance Period)	6 month slow release	19 : 0.3 : 9			
Turf (At Laying)	Turf Starter	20:12:4			
Turf (Maintenance Period)	Organic lawn fertiliser	10:4:5			
Trees	A mix of water crystals, wetting agent, inert carrier and fertilisers.	Equal to Terracottem or Terraform.			

HOLD POINTS / WITNESS POINTS - CHECKS REQUIRED

Landscape contractor shall provide the Superintendent notification of checks on progress of the works required and obtain approval to proceed following checking of hold points / witness points below.

REQUIRED WORK TO BE COMPLETED	NOTICE
Extent, excavation and setout of proposed works (HP).	2 Days.
Clarification on site of set-out points for any trenching or utility realignment (HP).	2 Days.
Form work and reinforcing (where applicable) (HP).	2 Days.
Pre-pour inspections for pavement and pathways (where applicable) (HP).	2 Days.
Set out and inspection of permeable pavement (where applicable) (HP).	2 Days.
Plants available on site or local nursery prior to planting.	2 Days.
Subgrades cultivated and / or prepared prior to placing topsoil.	2 Days.
Plant material set out prior to planting.	2 Days.
Completion of works as approved within the public footpath (WP).	2 Days.
Review of works as executed prior to completion report sign off (HP).	2 Days.
Completion of plant establishment work.	2 Days.

TICK	ACTION
	Check turf and garden areas for vehicular damage. If required, lift turf and backfill with topsoil to form an even grade and reinstate turf. Replaced displpaced soil in gardens and re-mulch as required.
	Mow and edge turf to 50mm mow height. Turf must not exceed 80mm height at any time. Remove visible lawn clippings and debris from turf.
	Prune back any groundcovers / shrubs overhanging kerbs, footpaths or other planting.
	Remove any broken or fallen branches from trees or access ways.
	Underprune trees as they mature to ensure the lower branches do not provide obstruction. Do not prune in excess of 1:3 canopy trunk ratio. Remove sucker growth from trees.
	Remove any weeds larger than 50mm high or wide from garden beds. Weeds 50mm and larger must be removed, not poisoned. There shall be no greater than 5% weed coverage in garden beds.
	Check plants for signs of stress or disease. Replace any plants that meet conditions for replacement at the contractor's expense. Request authorisation to replace other dead or missing plants. Note: Contractor must request authorisation to make replacements within one week of the damage becomming evident.
	Treat all plants, trees and turf for signs of disease or pest infestation. Turf shall be maintained in a healthy, vigorous condition, free from weeds, diseases and pests.
	Ensure that all plants and turf areas receive adequate water to sustain healthy growth.
	Inspect all hose tap connections and repair to maintain functionality.
	Sweep or blow clean all walkways, kerbs and gutters with scope of works.
	Remove pruning debris, mowing waste and rubbish off site on day or works being undertaken.
	Complete any items required on the Monthly Checklist.
	Add other items not included above if required.

MAINTENANCE CHECKLIST - MONTHLY

The following activities to be undertaken in conjunctio	n w

MONTH	ACTION				
JANUARY	No additional items.				
FEBRUARY	Inspect tree guards for damage and repair				
MARCH	Apply fertiliser to all massed planted areas of Submit receipts to Principal's authorised rep purchase.				
APRIL	No additional items.				
MAY	Remove accumulated soil and / or mulch fr regrade to match existing turf and garden I Inspect street tree guards and repair as req such as timber edging etc.				
JUNE	Apply new mulch to mass planting as requi Additional mulch not required where shrubs conceal the soil surface from view.				
JULY	Prune any tree branches that interfere with				
AUGUST	Apply fertiliser to all street trees, mass plantin water in. Submit receipts to the Principal's a fertiliser purchases.				
September	Apply new mulch to mass planting as requi Additional mulch not required where shrubs conceal the soil surface from view.				
OCTOBER	No additional items.				
NOVEMBER	No additional items.				
DECEMBER	Apply fertiliser to all street trees, mass plantin water in. Submit receipts to the Principal's a fertiliser purchases. Apply new mulch to mass planting as requir Additional mulch not required where shrubs conceal the soil surface from view.				

with the Weekly Maintenance Activities. air as required. as and street trees. epresentative as proof of fertiliser a from timber edging and locally n bed levels. equired. Repair any hard landscaping uired to maintain 75mm depth. ibs or groundcovers completely th public safety. Inting and turf areas and thoroughly a authorised representative as proof of quired to maintain 75mm depth. ibs or groundcovers completely authorised representative as proof of authorised repre

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vired to maintain 75mm depth. os or groundcovers completely

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REV	DATE	COMMENTS

PROJECT:

Aspect Autism School Schedules 01

SITE:

Harrisons Lane Cardiff

CLIENT:

Aspect Spectrum Australia



SAMPLING SCHEDULE			TREE WATERING RE	TREE WATERING REQUIREMENTS FOR NEW PLANTINGS			
ITEM	MIN. SIZE / QTY	MIN. TIME PRIOR TO USE	CONTAINER SIZE [litres]	APPLICATION RATES		WATERING	
Topsoil	2kg	In a sealed and labelled bag at least 5 working days before proposed use. Label to include name of supplier and contact details.		FREE DRAINING SOILS	HEAVY/CLAY SOILS	PERIOD 1 MINIMUM	
		In a socied and labelled bag at least 5 working days	45	10 litres	7 litres	0-6 months	
	11	In a sealed and labelled bag at least 5 working days before proposed use. Label to include name of	75	10 litres	7 litres	0-6 months	
Mulch	lkg	supplier and contact details.	100	20 litres	15 litres	0-6 months	
			150	30 litres	20 litres	0-6 months	
		In a sealed and labelled bag at least 5 working days before proposed use. Label to include name of	200	40 litres	30 litres	0-6 months	
Fertiliser	2kg	supplier and contact details.	250	50 litres	35 litres	0-6 months	
			300	60 litres	45 litres	0-6 months	
		At least two weeks prior to the proposed delivery	400	80 litres	60 litres	0-12 months	
	1/50 of each	date, in the condition in which it is proposed to supply that plant to the site. Plants to be made available at a	500	100 litres	75 litres	0-12 months	
Plant Materials	species or part thereof	site/nursery in the local area for inspection.	600	120 litres	90 litres	0-12 months	
			700	140 litres	105 litres	0-12 months	
			800	160 litres	120 litres	0-12 months	
		At least 5 working days before proposed use. Label to	1000	200 litres	150 litres	0-12 months	
Turf	1 roll	include name of supplier and contact details.	1200	240 litres	180 litres	0-12 months	
1			1500	200 litros	225 litros	0.12 months	

200	40 lit	tres	30 litres		0-6 months		7-12 months
250 50 lit		res	35 litres		0-6 months		7-12 months
300 60 litres		45 litres		0-6 months		7-12 months	
400 80 litres 6		60 litres		0-12 months		13-24 months	
500 100 litres 7		75 litres		0-12 months		13-24 months	
600 120 litres		90 litres		0-12 months		13-24 months	
700 140 litres		105 litres		0-12 months		13-24 months	
800	1601	itres	120 litres		0-12 months		13-24 months
1000	200	litres	150 litres		0-12 months		13-24 months
1200	240	litres	180 litres		0-12 months		13-24 months
1500 300 litres 225 litres			0-12 months		13-24 months		
				I			
TIME OF YEAR		WATER FREQUENCY				BALA	ANCE:
		1ST MONTH		2ND & 3F		PERI	ODS 1 OR 2
SEP - FEB		4 x PER WEEK		3 x PER V	VEEK	2 x F	PER WEEK
		(e.g. Mon/Wed/Fri/Sat)		(e.g. Mon/Wed/Fri)		(e.g. Mon/Thurs)	
MAR - MAY		3 x PER WEEK		2 x PER WEEK		1 × PER WEEK	
		(e.g. Mon/Wed/Fri)		(e.g. Mon/Thurs)			

WATERING DURATION

PERIOD 1: MINIMUM

PERIOD 2: PREFERRED

7-12 months

7-12 months

7-12 months

7-12 months

ABV	BOTANICAL NAME	COMMON NAME	HEIGHT	POT SIZE	SPACING	QTY.
	TREES					
EE	Eleaocapus eumundii	Quandong	8m	100L	as shown	15
ML	Melaleuca linarifolia	Snow in Summer	8m	100L	as shown	1
TL	Tristaniopsis laurina	Water Gum	12m	100L	as shown	14
	SHRUBS					
BI	Banksia integrifolia fastigiata	'Sentinel'	2m	25L	as shown	53
BB	Banksia spinulosa 'Birthday Candles'	Birthday Candles	0.5m	5L	4/m2	52
CV	Callistemon viminalis "Red Alert"	Red Alert	2m	25L	as shown	102
SR	Syzygium "Resillience"	Resillience	3m	25L	as shown	100
VO	Viburnum odoratissmum	Sweet Viburnum	3m	25L	as shown	36
	GRASSES / GROUNDCOVERS					
DC	Dianella caerulea 'Little Jess'	Little Jess	0.6m	2.5L	6/m2	18
DI	Dietes iridoides	White Iris	lm	2.5L	4/m2	299
DE	Doryanthes excelsa	Gymea Lily	1.5m	25L	as shown	150
GT	Gazania tomentosa	Silver Gazania	0.3m	2.5L	4/m2	264
GL	Grevillea lanigera 'Mount Tamboritha'	Mount Tamboritha	0.3m	2.5L	3/m2	18
HS	Hibbertia scandens	Snake Vine	lm	2.5L	3/m2	233
LM	Liriope muscari 'Variegata'	Lily Turf	0.5m	2.5L	6/m2	270
LL	Lomandra longifolia	Matt Rush	1m	2.5L	3/m2	195
LT	Lomandra longifolia 'Tanika'	Tanika	0.8m	2.5L	6/m2	68
PA	Pennisetum alopecuroides	Swamp Fox Tail	1m	2.5L	4/m2	178
PL	Poa ' Eskdale'	Eskdale	0.8m	2.5L	6/m2	210

This schedule shall be read in conjunction with the landscape plans. Refer to the written specification for further information. Th check the schedule with the quantities shown on the drawing. Quantities shown in the plant schedule shall take precedence a shown on the drawing. Refer a discrepancies, should they exist, to the superintendent before planting works commences. On soon as the head contract for the works has been let. Do not make substitutions unless approved in writing.

CONTAINER VOLUME (L)	MIN. ROOTBALL DIAMETER	HEIGHT ABOVE CONTAINER (M)		CALIPER (MM)	
		THICK STEMMED SPECIES	THIN STEMMED SPECIES	THICK STEMMED SPECIES	THIN STEMMED SPECIES
20	300		1.5	-	20
35	350	1.5	2	30	25
50	450		2.5	-	30
60	450		-	40	-
100	500	2.5	3	50	40
150	650		3.5	60	50
200	700	3.5	4	70	60
300	800		4.5	85	70
450	1000	4.5	5	105	90

TREE WATERING REQUIREMENTS

Create Watering Rings/Water-in.

Where trees are to be watered manually, create a watering ring for each tree, using site soil, that is approximately 100 mm – 120 mm high for trees up to 200 litre and 130 mm – 150 mm high for trees supplied that are greater than 200 litres such that:

 the inside diameter of the watering ring is less than the diameter of the root-ball this is to ensure that all water applied goes to the root-ball and not the site soils;

• the watering ring is wide enough and sufficiently robust to be durable;

the watering ring is big enough so that water can be applied at a rate of 20% of root-ball volume in a single application;

water trees in by applying water, through the watering ring, at a rate of approximately 40% of root-ball volume (2 applications of 20% of root-ball volume);

 Roots of the newly planted tree are in the rootball. Water applied must be directed to the rootball and watering the surrounding site soils can be, at best wasteful and at worst, damaging.

Continue to water trees as per instructions below:

	1ST MONTH	2ND & 3RD MONTHS	PERIODS 1 OR 2
SEP - FEB	4 x PER WEEK	3 x PER WEEK	2 x PER WEEK
	(e.g. Mon/Wed/Fri/Sat)	(e.g. Mon/Wed/Fri)	(e.g. Mon/Thurs)
MAR - MAY	<u>3 x PER WEEK</u>	2 x PER WEEK	1 x PER WEEK
	(e.g. Mon/Wed/Fri)	(e.g. Mon/Thurs)	
JUNE - AUG	2 x PER WEEK	1 x PER WEEK	1 x PER FORTNIGHT
	(e.g. Mon/Thurs)		
* DELETE A WATERIN EXCEEDS 50mm.	G IF RAINFALL OCCURS 48 H	OURS PRIOR TO A SCHEI	DULED WATERING &
WEED CONTROL SCH	HEDIJIE		

WEED CONTROL SCHEDULE				
WEED TYPE	CONTROL METHODS			
Stripped Soil Stockpile	Glyphosate two weeks prior to stripping.			
Mass Planting Areas	Hand weeding.			
	Selective herbicide approved for nominated species.			

412 KING STREET NEWCASTLE NSW AUSTRALIA 2300 TERRAS.COM.AU PH: 49 294 926 FAX: 49 263 069



drawn: GF DATE: 22.09.23 scale: NTS@A3 JOB NUMBER: 13753.5 DD L502 M

PHASE: DWG No: REV:

Aspect Spectrum Australia

CLIENT:

SITE: Harrisons Lane Cardiff

Aspect Autism School Schedules 02

PROJECT:

М	22/09/23	TENDER
L	02/08/23	TENDER
К	25/07/23	TENDER
J	21/07/23	TENDER
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SCHEDULES - MATERIALS AND FINISHES

NOTE: use proprietary items as specified below or similar item equal in workmanship, materials and design if approvedby the Superintendent.

STAKES AND TIES SCHEDULE			
CONTAINER SIZE	INSTALLED HEIGHT	ТҮРЕ	
< 45 Litre	Minimum 1200mm AGL installed.	2 x 35mm hardwood stakes. Loose hessian ties.	
45 - 200 Litre	Minimum 1500mm AGL installed.	3 x 50mm hardwood stakes. Loose hessian ties.	

TURF SCHEDULE

CODE	FORMAT	ТҮРЕ
TI	Rolls	Sir Grange Tiff Tuff
T2	Synthetic Turf	Synthetic Turf
		Supplier: Australian Synthetic lawns
		Type: "NoMo Cool 40mm"
		Description: 40mm pile synthetic turf, 4 tone mono filament. Non carcinogenic. Lead and heavy metal free.
		Colour fastness: min ref standard 8 blue scales
		'Topdressing' infill: 15 - 20mm depth, fine washed kiln dried and graded silica sand, application rate as pe
		manufacturer's recommendations.
		Refer detail for bedding sand and subgrade treatment
		Affix to sub base as recommended by manufacturer Provide sufficient fixings so as not to create trip hazards.
		Glue fix turf pile to adjacent vertical surfaces, as detailed.
		Manufacturer's warranty: provide min 7 year warrant on UV resistance.
		Available from: Grassman Grass Manufacturers, Botany NSW. P 02 9316 7244.
		www.grassman.com.au
		Submit sample for approval prior to installation.

SOIL SCHEDULE	
LOCATION	DEPTH (MM)
Mass Planting	400
Turf	200
Trees	Top 300mm
Trees	Below 300mm

MULCH SCHEDULE				
CODE LOCATION		DEPTH (MM) / EXTENTS	ТҮРЕ	
	Mass Planting & Street Trees.	75	100% recycled grade A green waste. Woodchip. No fines. Equal to ANL Forest Blend ®	

PLANTIN	LANTING POT SCHEDULE	
CODE	ТҮРЕ	
PL1	Container Connection Fibreglass planter 1500 x 500 x 500mm Concrete Grey	

CODE	ТҮРЕ
P1	Supplier: Stonekast Size: 500 x 500mm Unit paver Colour: Hudson. Finish: Shot
P2	Coloured concrete to engineers details. Colour: CCS "Rhino" 3% in grey cement Finish: Coving trowel

DRAINAG	DRAINAGE SCHEDULE		
CODE	LOCATION	туре	
SSD	Mass Planting & Street Trees	Perforated plastic pipe: To AS 2439.1. Diameter: 90mm. Junctions: Use purpose made fittings. Filter Fabric: Use polymeric fabric formed from a plastic yarn containing stabilizers or inhibitors to make the filaments resistant to deterioration due to UV light Backfill: Use 20mm nominal size washed screenings. Connect to stormwater system.	
EDGE SC	HEDULE		
CODE	LOCATION	ТҮРЕ	
TE	At interface of turf and mass planting, as shown on the Landscape Plans.	Timber Edge Edging: 100 x 45mm H4 treated pine. Joiner: 75 x 15 x 450mm long H4 treated pine. Stakes: 50 x 50 x 450mm long hardwood stakes @ max.1200mm centres.	

CODE	LOCATION	
TE	At interface of turf and mass planting, as shown on the Landscape Plans.	Timber Edge Edging: 100 x 45mm H4 treated pine. Joiner: 75 x 15 x 450mm long H4 treated pine. Stakes: 50 x 50 x 450mm long hardwood stakes @ max.1200mm centres.
RE	At interface of turf and mass planting, as shown on the Landscape Plans.	Rock Edge Edging: Benedict - 1 man rock (300-500mm)
CE	At interface of synthetic turf and mass planting / turf, as shown on the Landscape Plans.	Concrete Edge 100 + 100mm wide concrete edge with 20mm setdown for synthetic turf fixing - refer detail

SANDSTO	ANDSTONE LOG SCHEDULE		
CODE	түре		
SL1	Size: 1000 x 500 x 500mm sandstone block. Supplier: Gosford Quarries, First Grade quality, with sawn face to top as sitting surface. Colour: Mount White brown sandstone. Contact: sales@gosfordquarries.com.au Ph: 4340 3000 Note: Ensure blocks sit firmly on compacted sub-base without rocking		

SOFTFALL SCHEDULE		
CODE	ТҮРЕ	
SF1	Rosehill TPV: 1 part Turquoise, 1 part Light Blue, 1 part Pale Grey	Renth TPC for a Mar.
SF2	Rosehill TPV: 1 part Creme, 1 part Beige	Result TV Good ther Notes that the second s

ROOT CO	COOT CONTROL BARRIER SCHEDULE	
CODE	ТҮРЕ	
RCB	Equal to Arborgreen Landscape Products "Re Root 600". Or as per de	
FURNITUR	E SCHEDULE	
CODE	ТҮРЕ	
B1	Draffin Street Furniture - Wandin Semi Circular Bench. 2 each setting Code: 89042 Size: 1455mm(inner dimension), 2265mm (outer dimension) x 405mm x Battens: Timber-look Aluminium- Alpine Ash Frame: Black Powdercoated Fixing: Flat Bar Legs	
FENCE SC	CHEDULE	
CODE	ТҮРЕ	
F1	Equal to Dunn and Farrugia pool Fencing (Ensure balustrade complic Flat top	

Fl	Equal to Dunn and Farrugia pool Fencing (En Flat top Black Gates as shown
F2	Colourbond fencing 1.8m Woodland Grey
F2	Equal to Dunn and Farrugia security fencing Capped top Black Gates as shown

cturer: Moduplay Name: K-9775 Spectra Orbit cturer: Moduplay Name: S-9900 Capital Nest Swing cturer: Moduplay Name: Konnecta Horizontal Square Net Climber
Name: K-9775 Spectra Orbit cturer: Moduplay Name: S-9900 Capital Nest Swing cturer: Moduplay Name: Konnecta Horizontal Square Net Climber
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Name: Konnecta Horizontal Square Net Climber
Name: Konnecta Horizontal Square Net Climber
aturar Madualau
cturer: Moduplay Name: U-9604 Summit Turtle
cturer: Moduplay Name: D-8826 1.8m Wide SS Slide with SS Entry Rail
cturer: Park Equip Name: 126202A Splash Circuit
cturer: Play works Name: log steppers (150-200mm) PN1195(200-250mm) PN1205(250-300mm)

TGSI SCHEDULE		
	CODE	ТҮРЕ
	tgsi	Polyurethane Discrete Warning Tactile Indic

icator, Black.



TERRAS.COM.AU PH: 49 294 926 FAX: 49 263 069



DATE: 22.09.23 drawn: GF scale: NTS@A3 JOB NUMBER: PHASE: DWG No: REV: 13753.5 DD L503 M

CLIENT: Aspect Spectrum Australia

SITE: Harrisons Lane Cardiff

Aspect Autism School Schedules 03

PROJECT:

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Ensure balustrade compliance)

outer dimension) x 405mm x 430mm high

"Re Root 600". Or as per detail.